

DESIGN REVIEW BOARD APPLICATION

Administered by: Design Review Board

Property Address*:37	1 South Main St			
Applicant Name & Mailing A	ddress: Stev	e Carter P.O.	Box 172063 Memphis	s, TN 38187
Applicant Phone Number:	601-383-6851	Арр	olicant Fax Number:	n/a
Property Owner's Name & N	Mailing Address:	Miguel Gomez	6052 Memphis Arlin	gton Rd Bartlett, TN 38135
Property Owner's Phone Nu	mber: 901-3	35-7457		
	s of the following (on under the following (on the following under the following (or following under the f	check all that app Renovation d Other Exterior	.,	
will be added so that the	upper and lower floor orically appropriate hi Il be cleaned and rep d will include colored a concrete parking lo	rs may be lease by igh quality construct or construct or contract in the gentless and stamped concept will be added, and	multiple tenants if desination; architectural lighti st means possible, and crete, a new exterior sta	ir, wrought iron fencing,
The project received apple through the DMC DRB are				nd is not seeking approval nce in spring of 2021.
A complete application in before a regularly sched (901)575-0565 or alueders@	uled meeting of	the Design Rev	iew Board. Please c	
Owner/Applicant Signature:	1.0	Type and		
Date:	2/16/21			

^{*}Applications for properties that are located within a Landmarks Historic District may require additional approval from the Landmarks Commission. Please contact the Shelby County Division of Planning & Developement at (901) 576-6601 for more information.



Katie Flynn
Development Project Manager
Downtown Memphis Commission
114 N. Main Street
Memphis TN 38103

RE: 371 South Main, Exterior Lighting

A2H # 19545

Dear Katie,

Thank you for the opportunity to resubmit our drawings for the design review board's consideration. Since we last were on the agenda (12/2/20) we have completed our construction drawings. The attached drawings are a portion of that set, specifically, those sheets which touch on lighting.

I've noted our response to each of the board's concerns below:

1. Details for mounting the fixtures along Main St. in the existing beam above the storefront entry are needed.

See detail D1/A6.2. The fixture will mount directly to the steel angle over the window. The electrical box will be mounted in the interior face of the wall,

2. More details are needed for the bollard style light on top of the open railed landing - concerns in how that will look.

This light has been removed. We now show a series of step lights recessed into stair risers. https://bklighting.com/collaterals/specs/specs-1341.pdf

The elevation on Talbot does not match existing conditions nor does it match light placement on the lighting plan provided.

The Talbot elevations have been completed, and how show accurate transom windows and masonry opening sizes. See drawing D1/A2.1

4. The rear elevation shows discrepancies amongst the height of the roof canopy. Notice the side elevation and the actual height of the roof canopy which show that there is not as much room at the second floor breezeway as the drawing indicates (this matters when considering the Talbot Elevation):

The height of the ceiling at the 2nd floor canopy has been corrected. New enlarged elevations on A2.2, which dimension the light fixture mounting locations, also now show the ceiling accurately.

5. The previous application had the wall sconces mounted to the side of the entry doors along Talbot. The current application shows them mounted above the doors in areas that seem implausible.

Light fixtures along Talbot have been moved back to the side of doors, see A2.1 and A2.2

Thank you again for the opportunity to resubmit. We look forward to further dialogue!

Sincerely,

Brad Schmiedicke AIA Senior Architect

JB (com/ bickly


• The fixture itself should not be a feature; rather it should more or less disappear during daylight hours, and let the original façade stand on its own.

This elevation and photometric study below illustrate how this will work:



Additionally, fixtures on the Talbot façade should match (or compliment) those visible from main street
on the north façade. The selected fixture seems appropriate for both facades, whereas a decorative
lighting fixture would likely be inappropriate on the Talbot façade.

• Finally, the proposed fixture includes a down-light variant appropriate for the courtyard / rear balcony. Again, they are unobtrusive, and do not seek to draw attention away from the building itself, and present a cohesive lighting package.

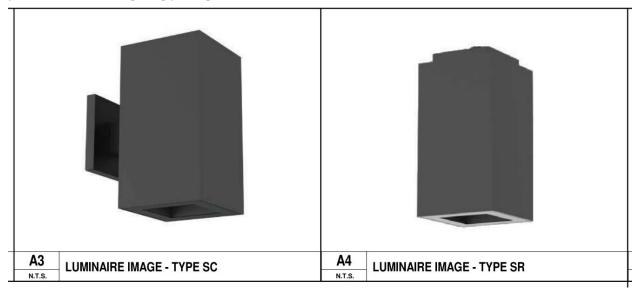


Thank you again for the opportunity to better articulate our thoughts on the lighting design. We look forward to further dialogue!

Sincerely,

Brad Schmiedicke AIA Senior Architect

CC: Katie Flynn – Downtown Memphis Commission

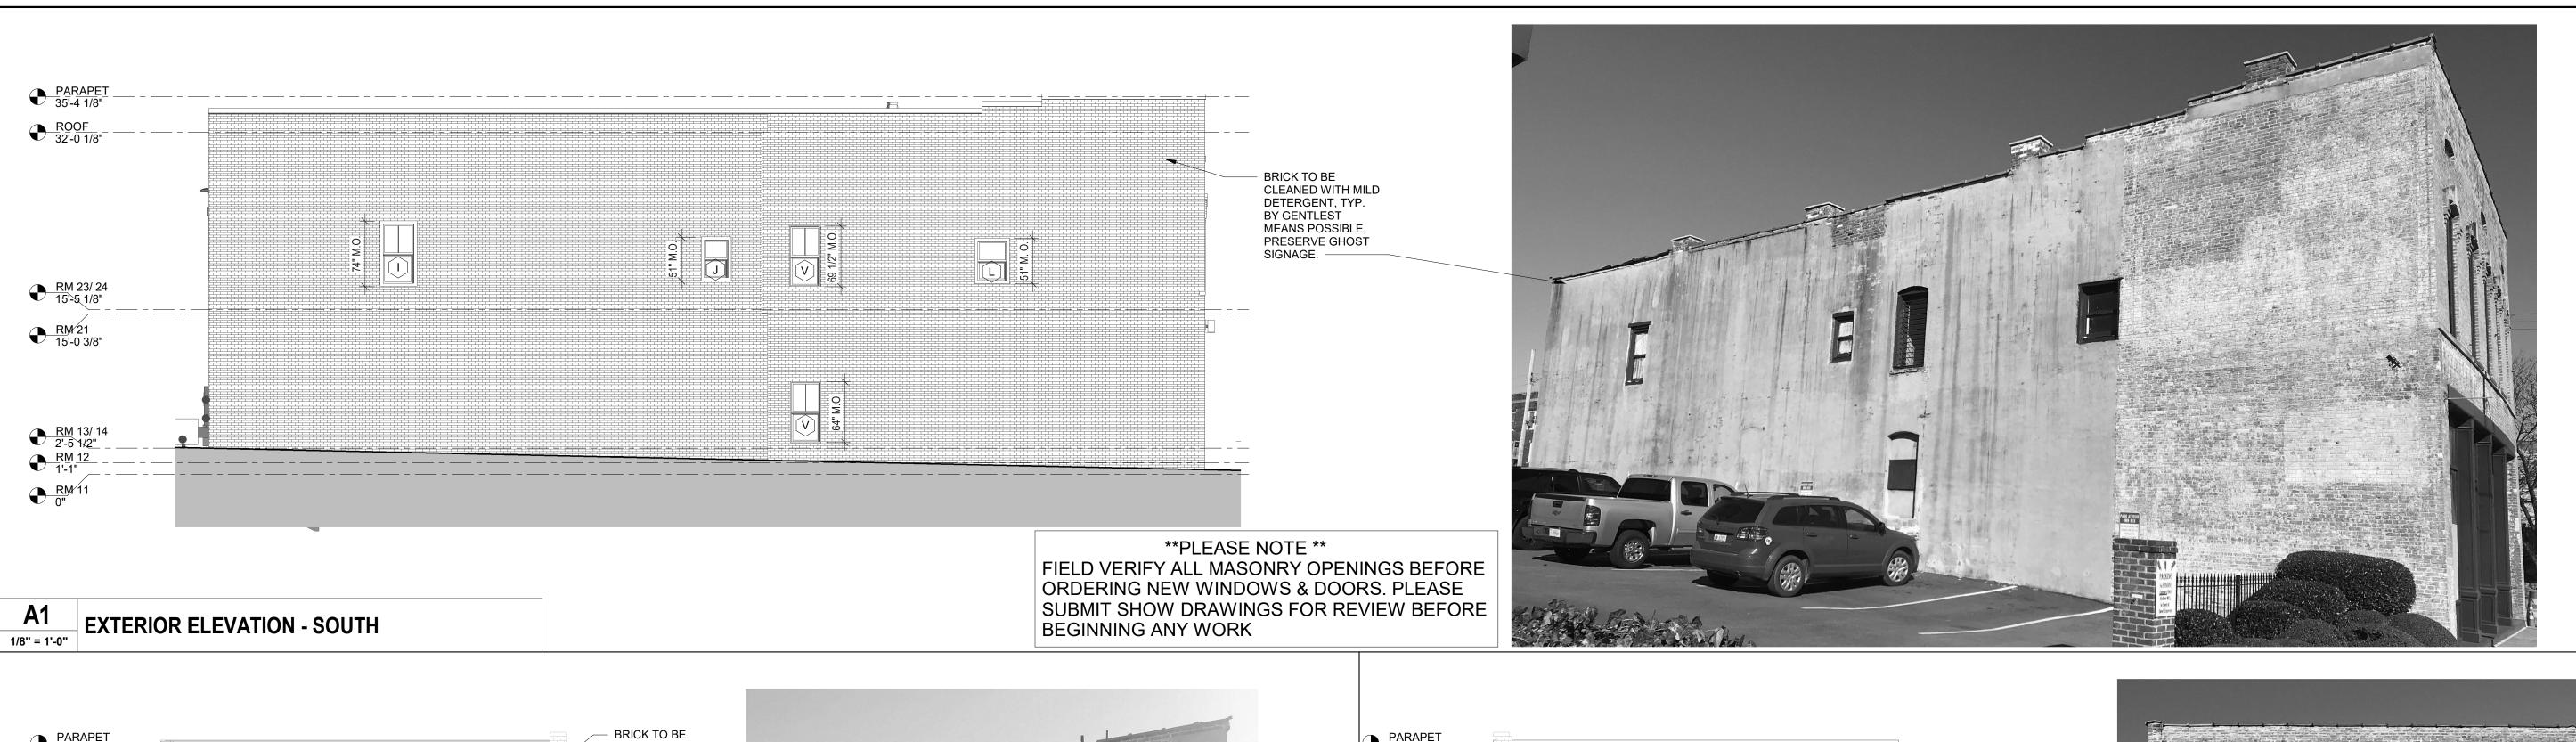

GOMEZ FAMILY

371 SOUTH MAIN STREET REDEVELOPMENT

A2H, INC.

P. 901.372.0404 WWW.A2H.COM

371 SOUTH MAIN STREET, MEMPHIS, TN 38103

PERMIT SET

REVISIONS 2/5/2021 ADDM #1

CHECKED


EXTERIOR ELEVATIONS

BRICK TO BE
CLEANED WITH MILD
DETERGENT, TYP.
BY GENTLEST
MEANS POSSIBLE,
PRESERVE GHOST ROOF 32'-0 1/8" SIGNAGE. RM 21 15'-0 3/8" REMOVE STEEL BRACE AND FOUNDATIONS **NEW STAIRS** RM 13/ 14 2'-5 1/2" - METAL DOWNSPOUT, CONNECT TO UNDERGROUND STORM DRAIN ELECTRICAL SERVICE - EXISTING EXTERIOR STRUCTURE TO BE REMOVED


C1

1/8" = 1'-0"


EXTERIOR ELEVATION - WEST

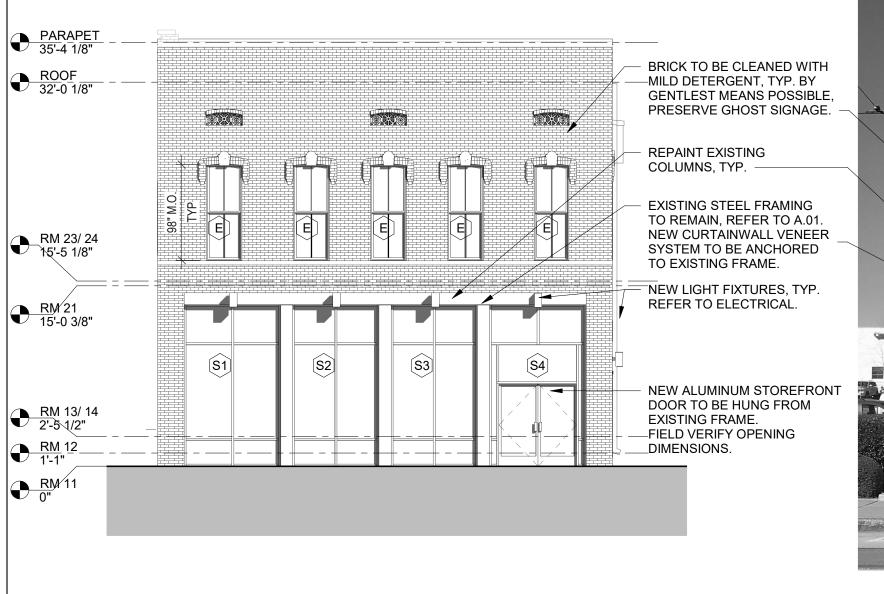


C3 EXTERIOR ELEVATION - EAST

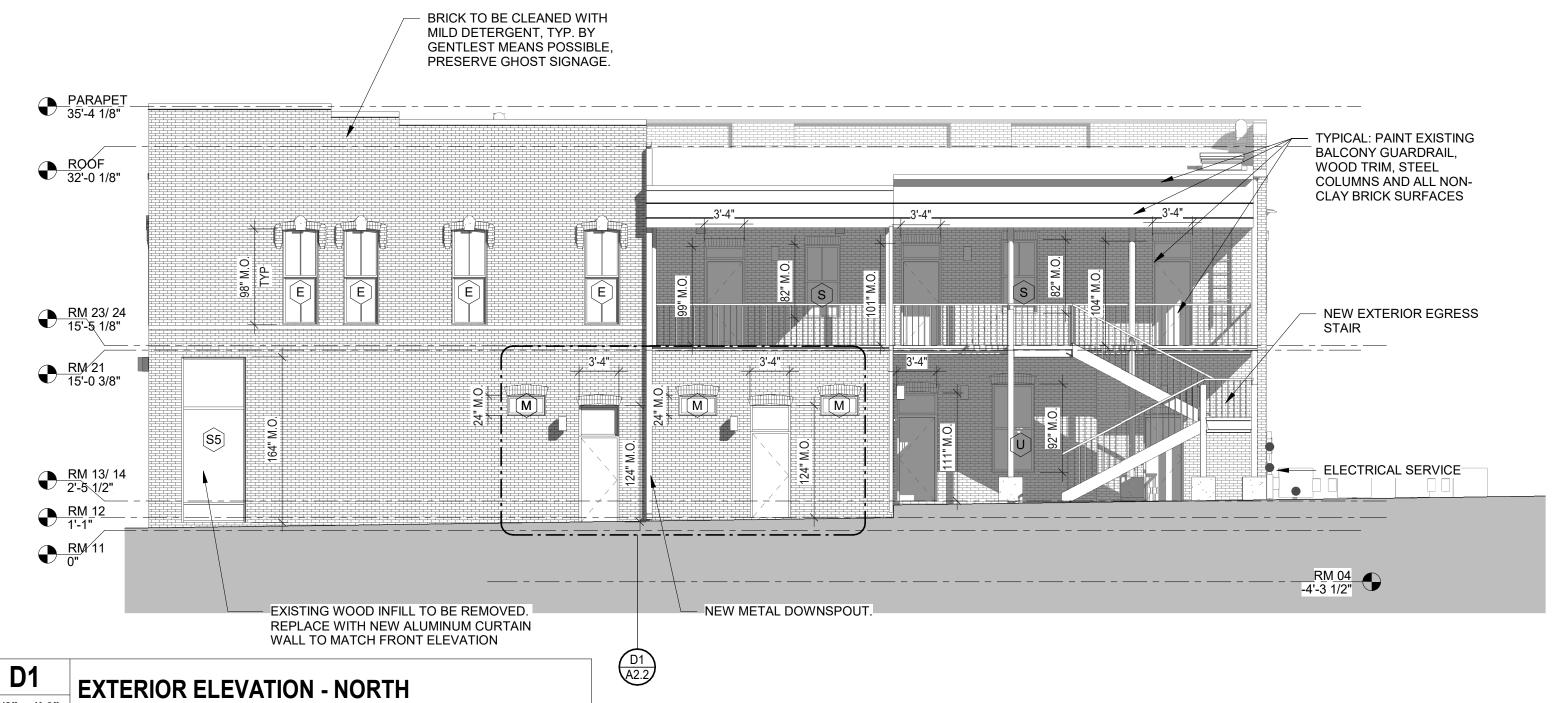



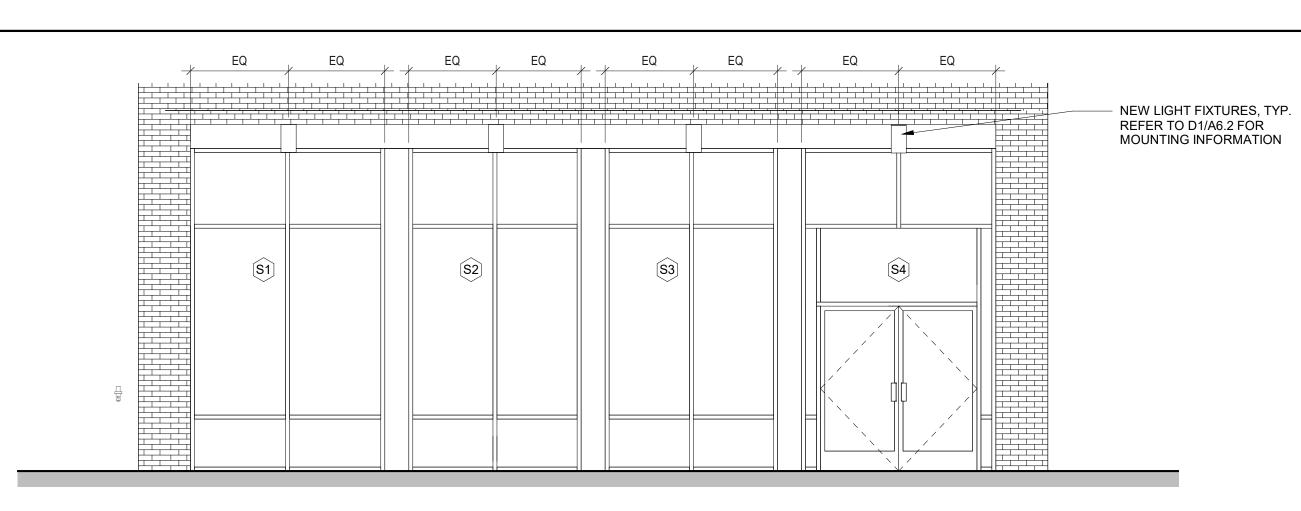


A1 EXTERIOR ELEVATION - MAIN STREET LIGHTING

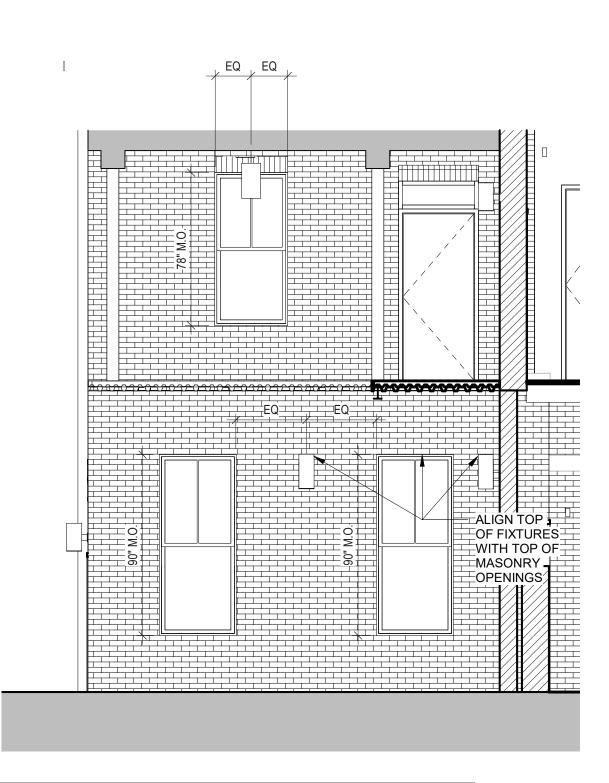

C1

| EXTERIOR ELEVATION - WEST LIGHTING

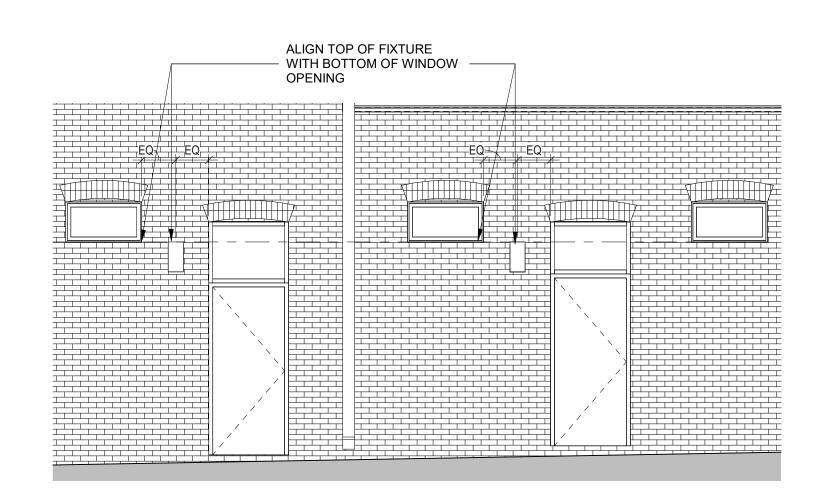

24 ENGINEERS ARCHITECTS PLANNERS

A2H, INC. 3009 DAVIES PLANTATION ROAD LAKELAND, TN 38002 P. 901.372.0404 WWW.A2H.COM

GOMEZ FAMILY

371 SOUTH MAIN STREET REDEVELOPMENT

371 SOUTH MAIN STREET, MEMPHIS, TN 38103

PERMIT SET

REVISIONS 2/5/2021 ADDM #1

PROJECT NO. DATE
19545 1/22/21

DRAWN CHECKED
Author Checker

EXTERIOR ELEVATIONS

122





AZH, ING.
3009 DAVIES PLANTATION ROA
LAKELAND, TN 38002
P. 901.372.0404



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371 SOUTH MAIN STREET REDEVELOPMENT

371 SOUTH MAIN STREET, MEMPHIS, TN 38103


PERMIT SET


REVISIONS


PROJECT NO.	DATE
19545	1/22/21
DRAWN	CHECKED
NL	BS

PERSPECTIVE

Δ23

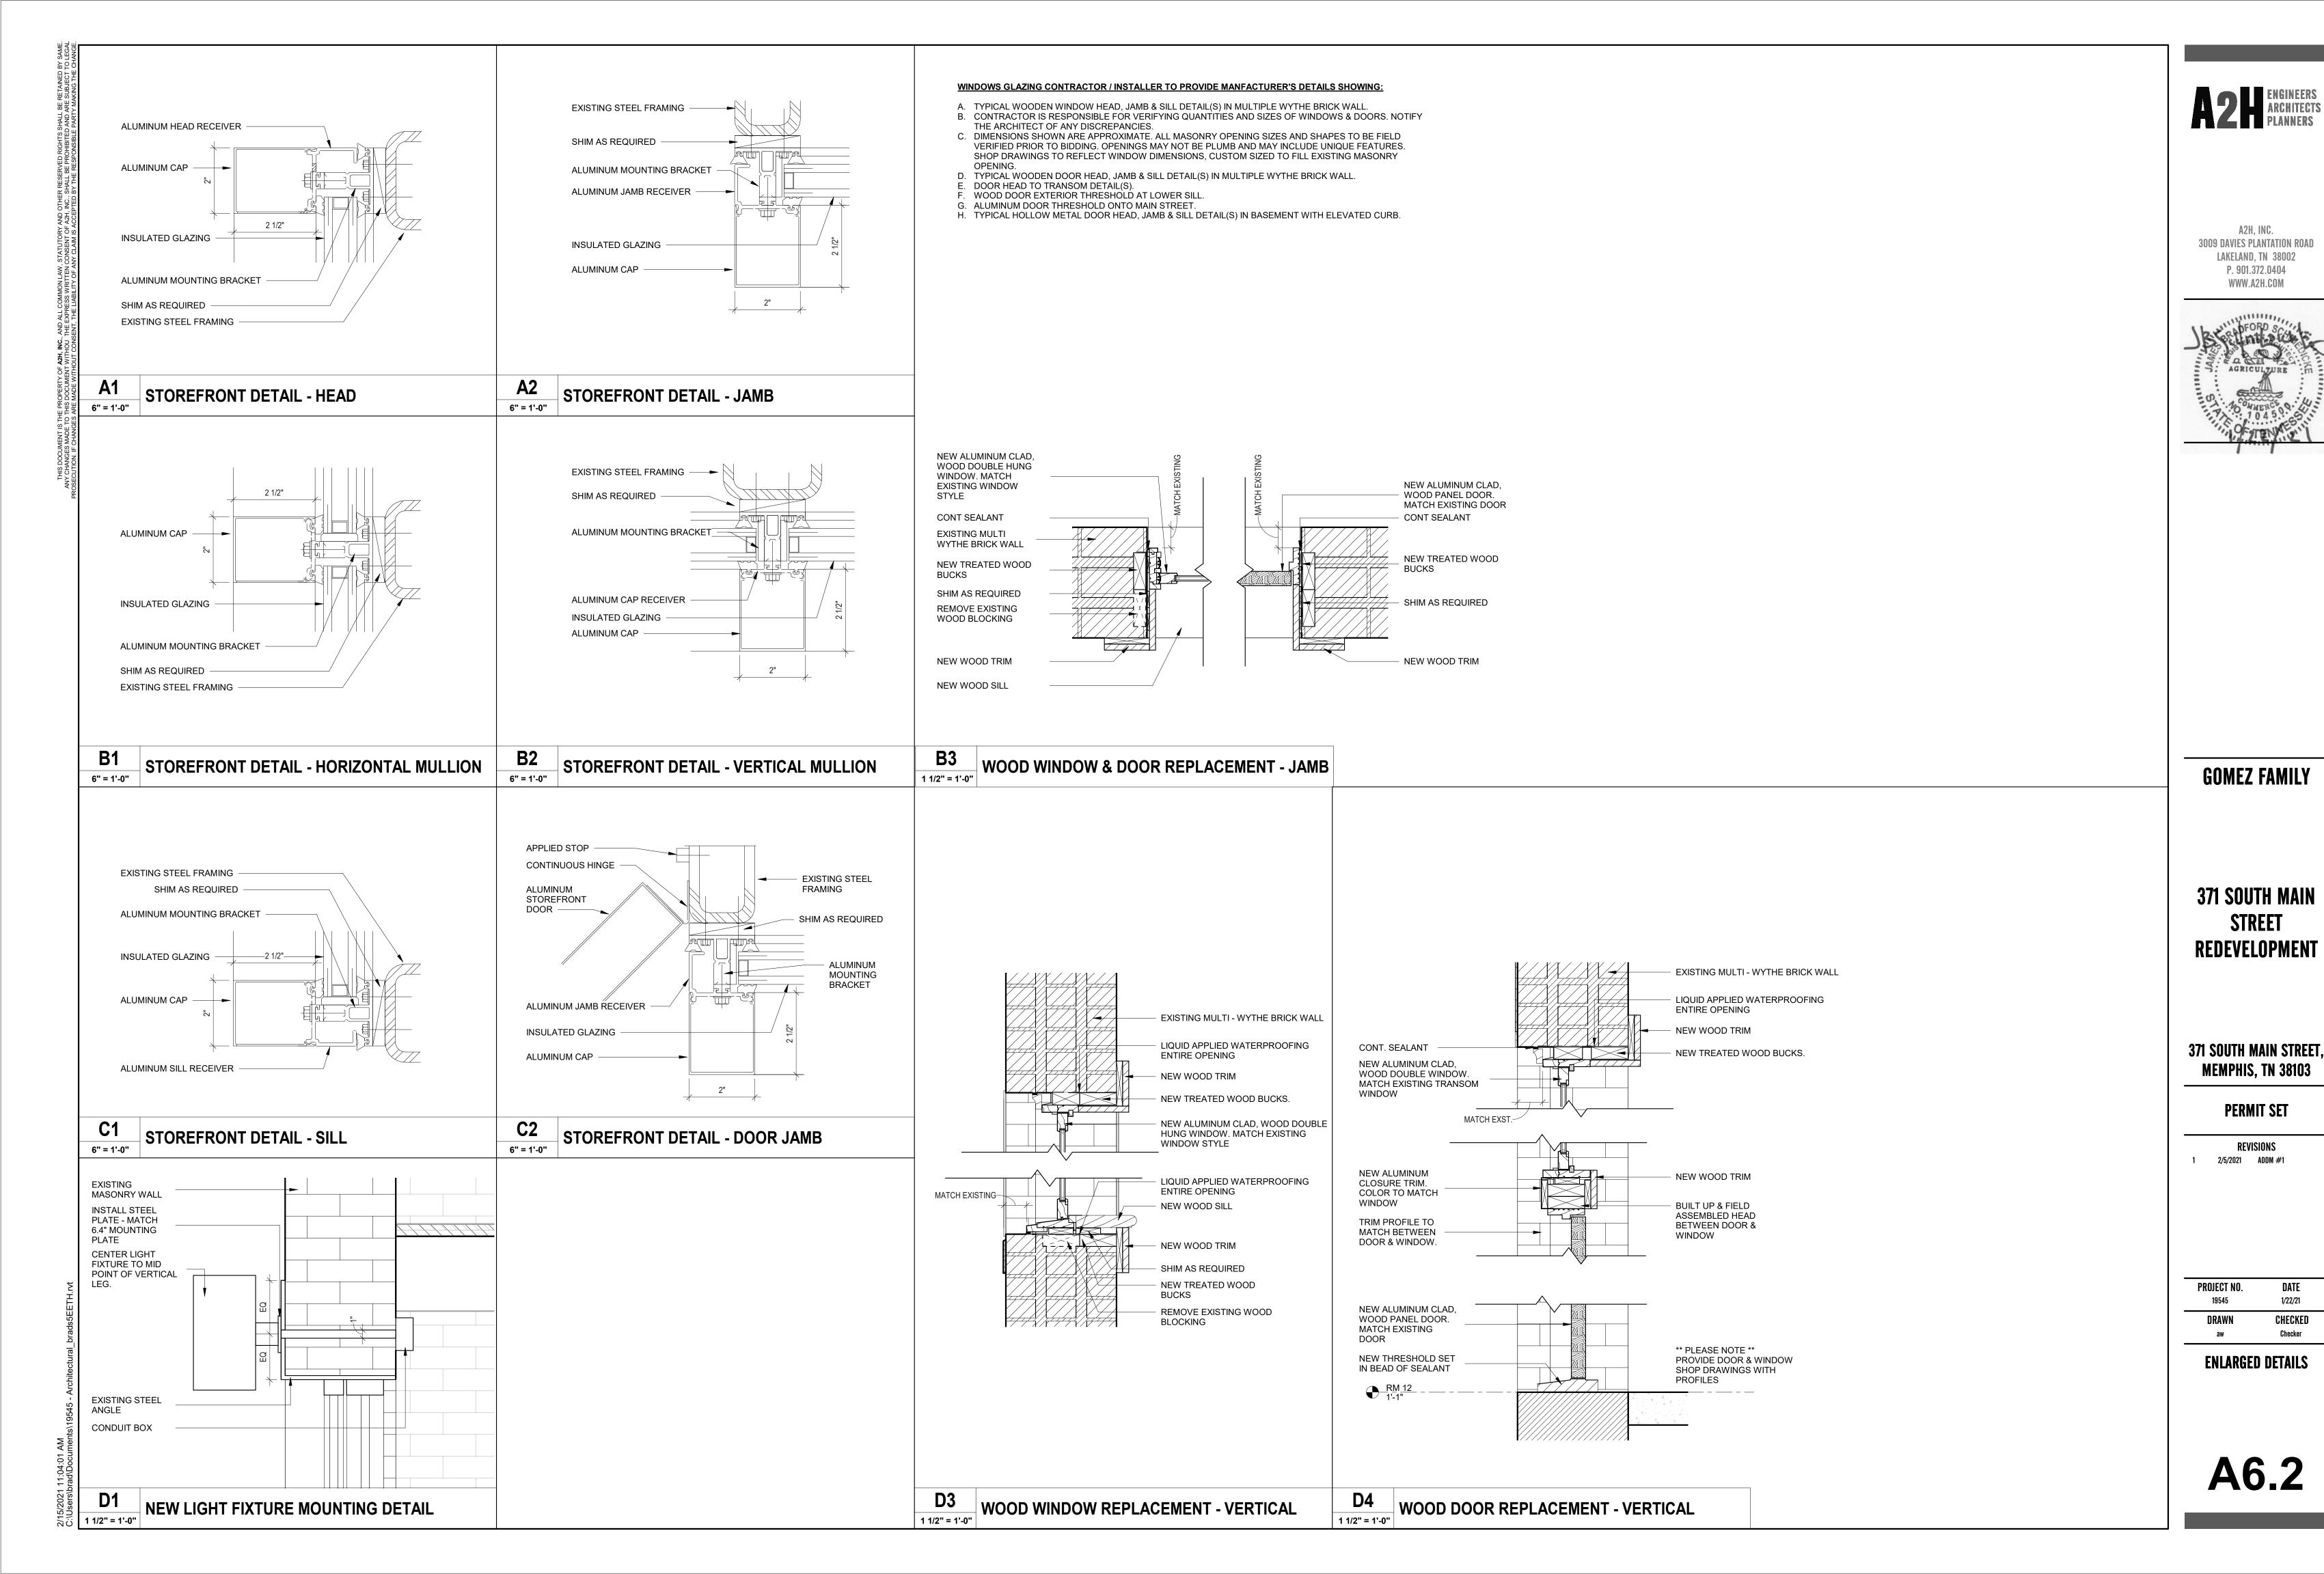

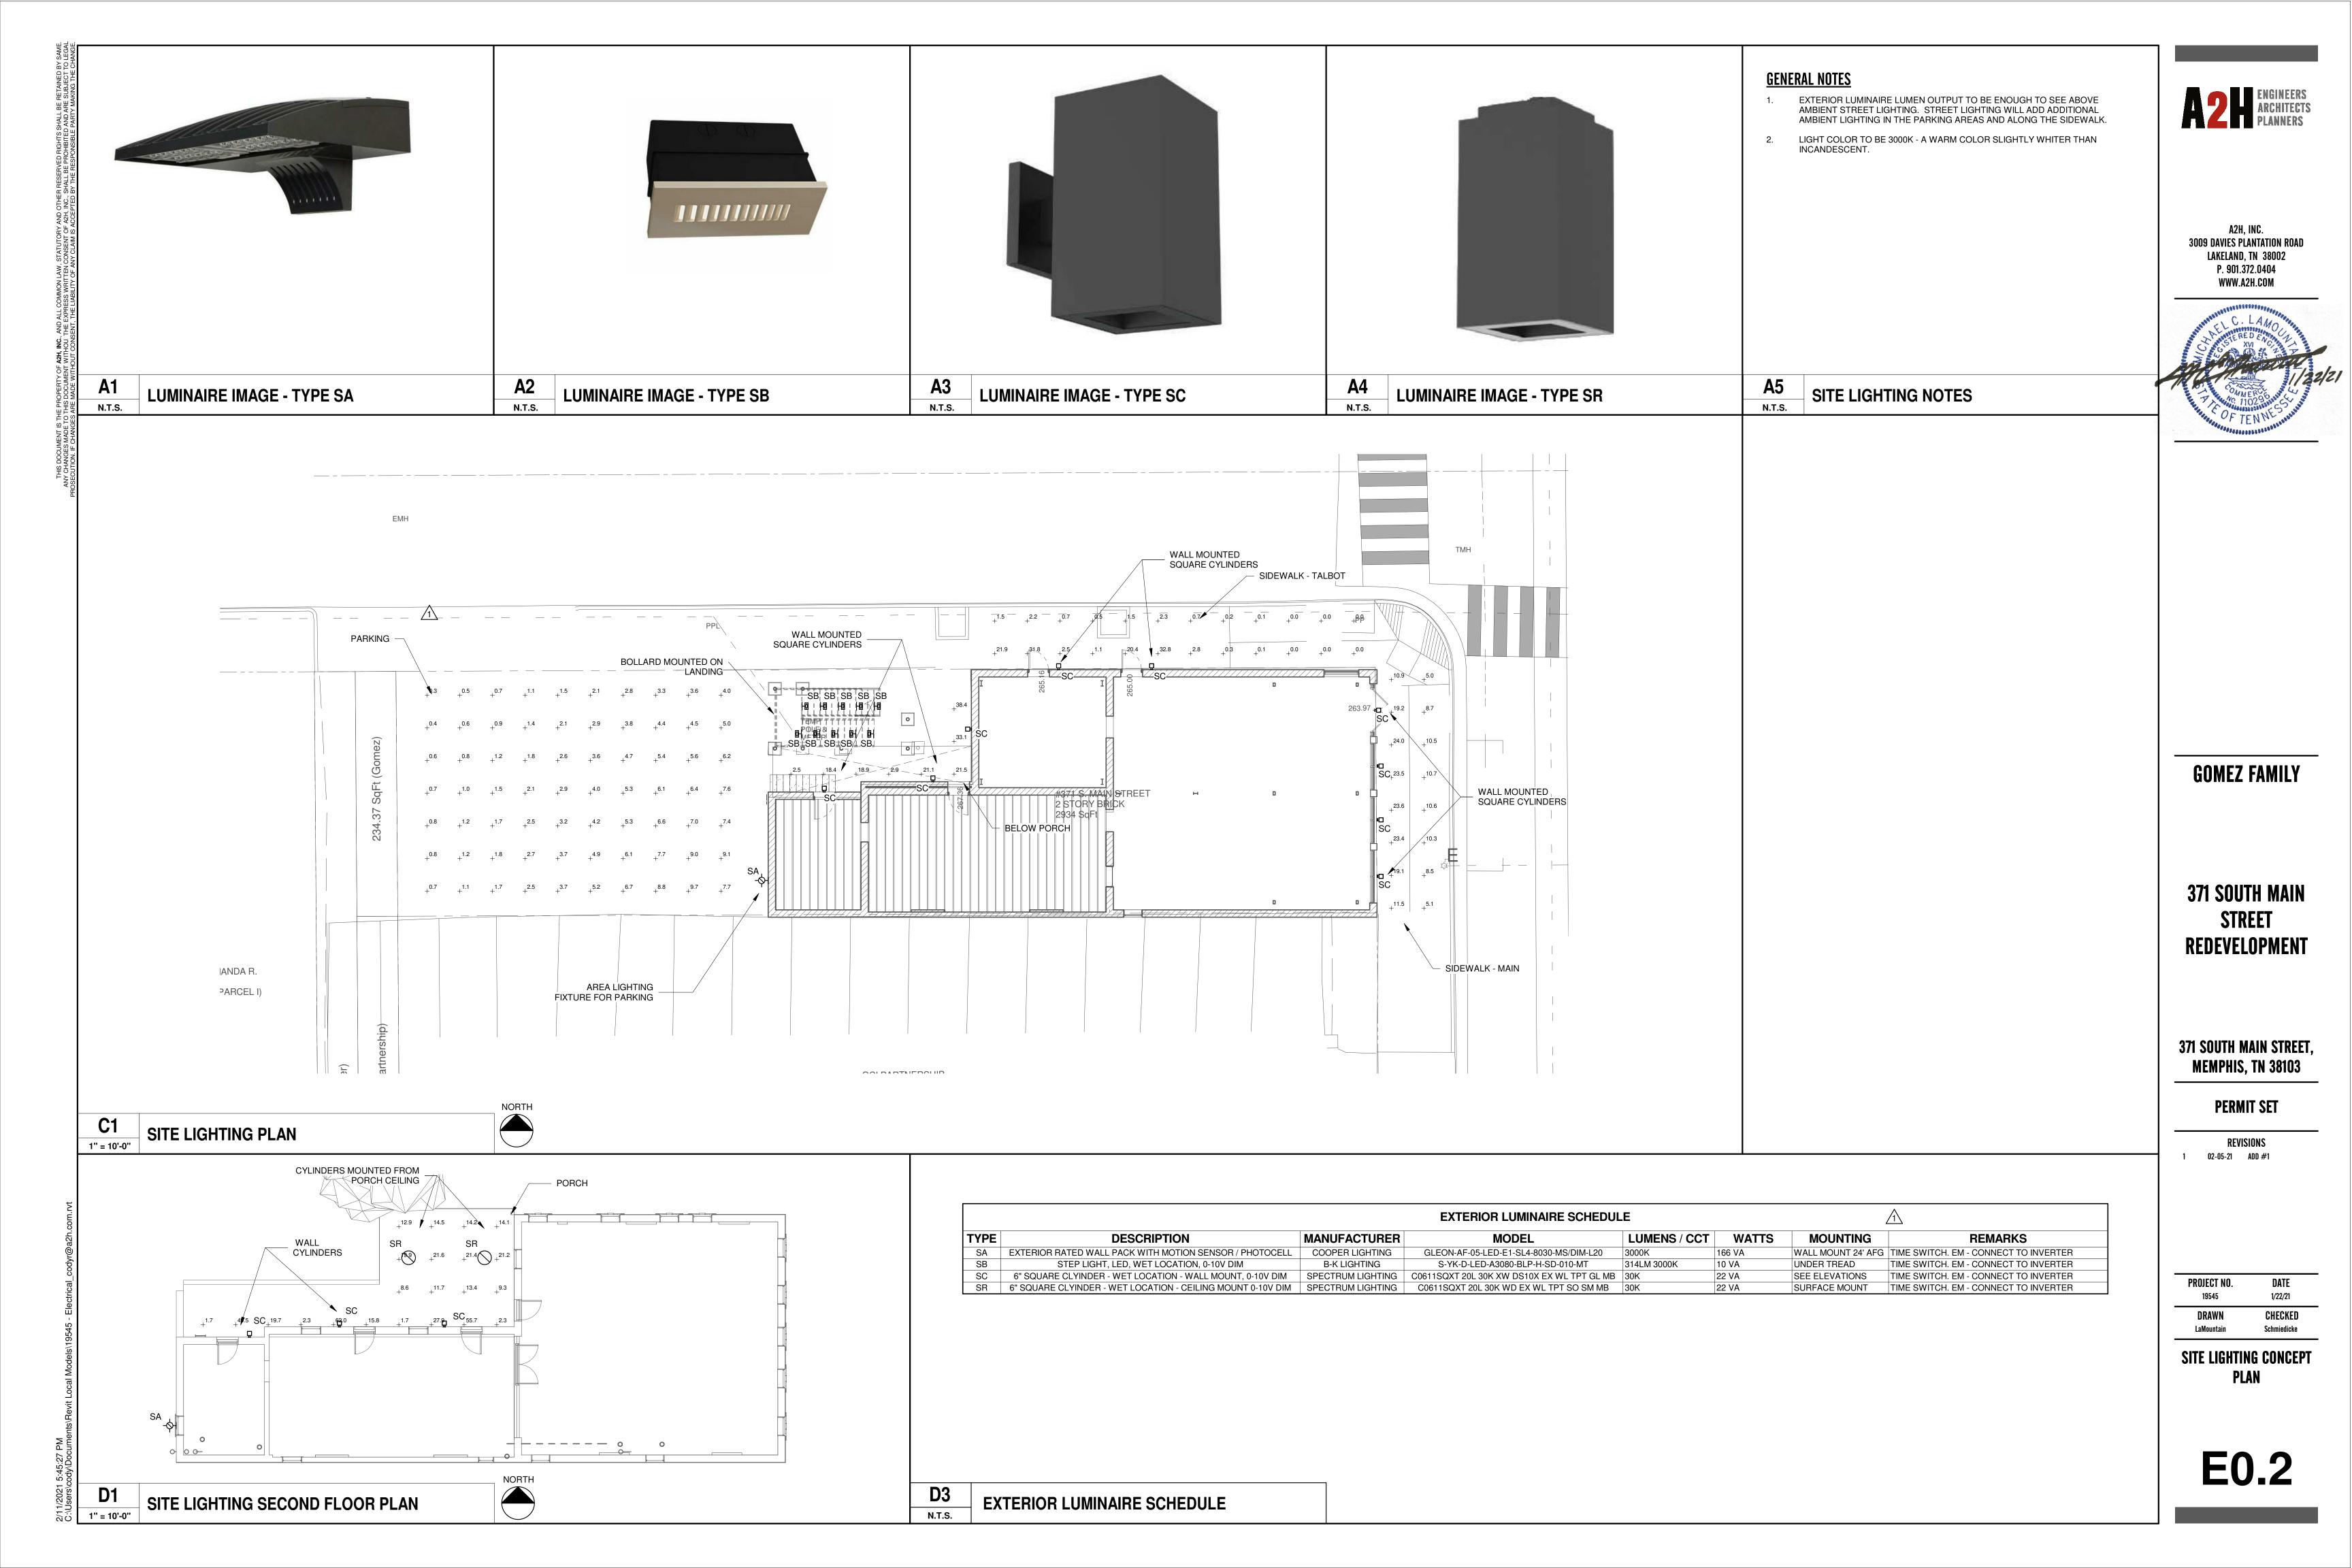

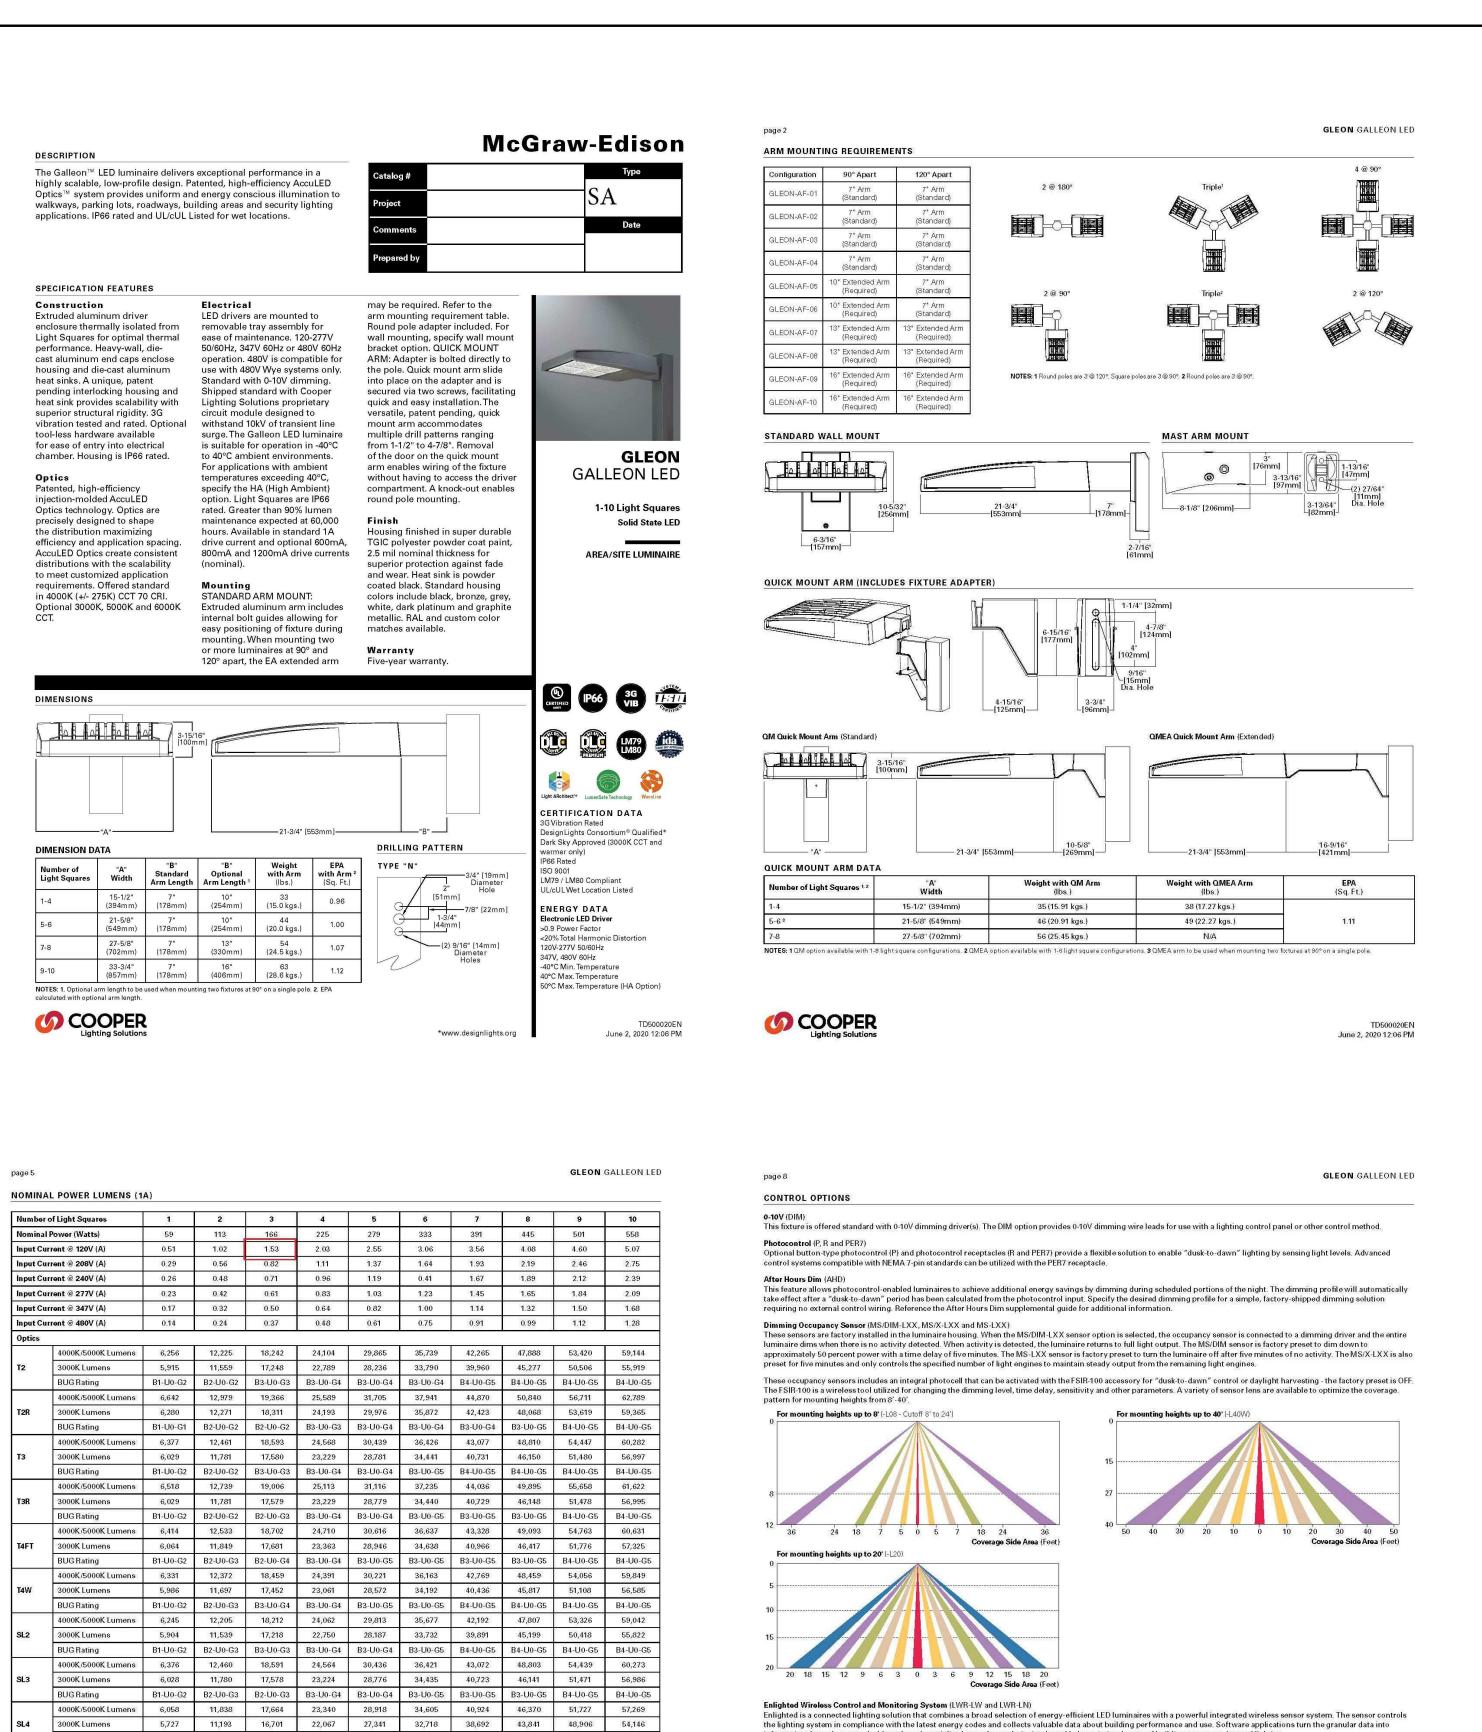

on through energy dashboards and specialized apps that make it simple and help optimize the use of building resources, beyond lighting.

Coverage Side Area (Feet)

The 7-pin wireless outdoor lighting control module enables WaveLinx to control outdoor area, site and flood lighting. WaveLinx controls outdoor lighting using schedules to provide ON, OFF and dimming controls based on astronomic or time schedules based on a 7 day week.

Cooper Lighting Solutions brings ease of camera deployment to a whole new level. No additional wiring is needed beyond providing line power to the luminaire. A variety of networking options allows security integrators to design the optimal solution for active surveillance. As the ideal solution to meet the needs for active surveillance, the LumenSafe integrated network

camera is a streamlined, outdoor-ready fixed dome that provides HDTV 1080p video. This IP camera is optimally designed for deployment in the video management system or security

SimplySNAP integrated wireless controls system by Synapse. Includes factory installed DIM10 Synapse control module and MS/DC motion sensor; requires additional Synapse

For mounting heights from 16' to 40' (LWR-LN)


June 2, 2020 12:06 PM

For mounting heights from 8' to 16' (LWR-LW)


LumenSafe Integrated Network Security Camera (LD)

COOPER

June 2, 2020 12:06 PM

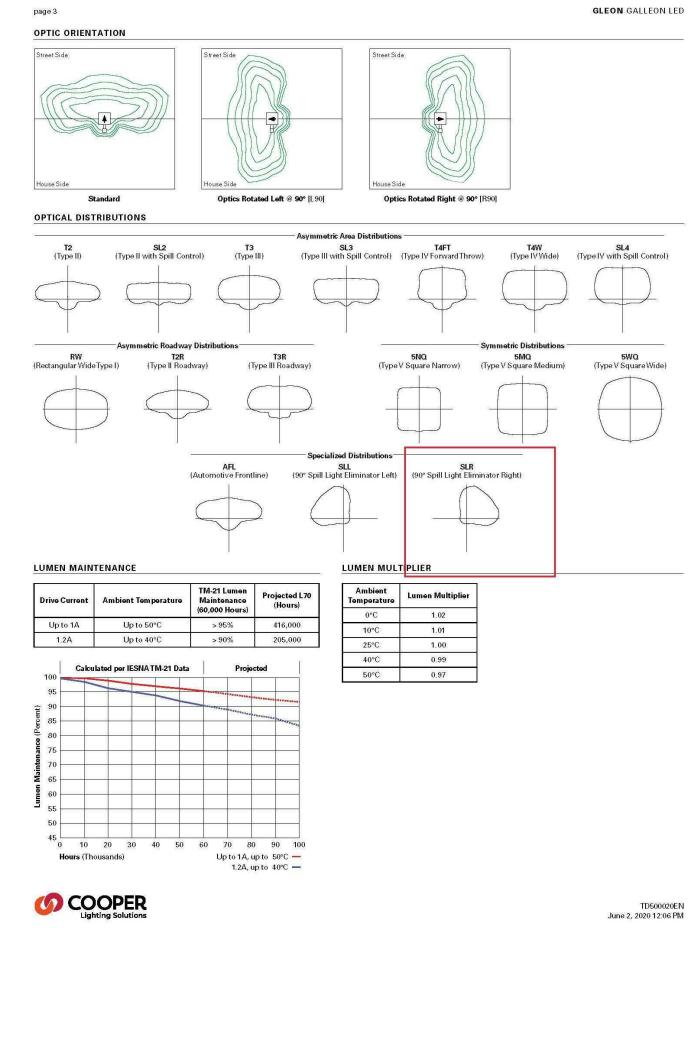

7027=70 CRI 2700K ¹³ 7030=70 CRI 3000K ¹³ 8030=80 CRI 3000K ¹³ 7050=70 CRI 5000K ¹³

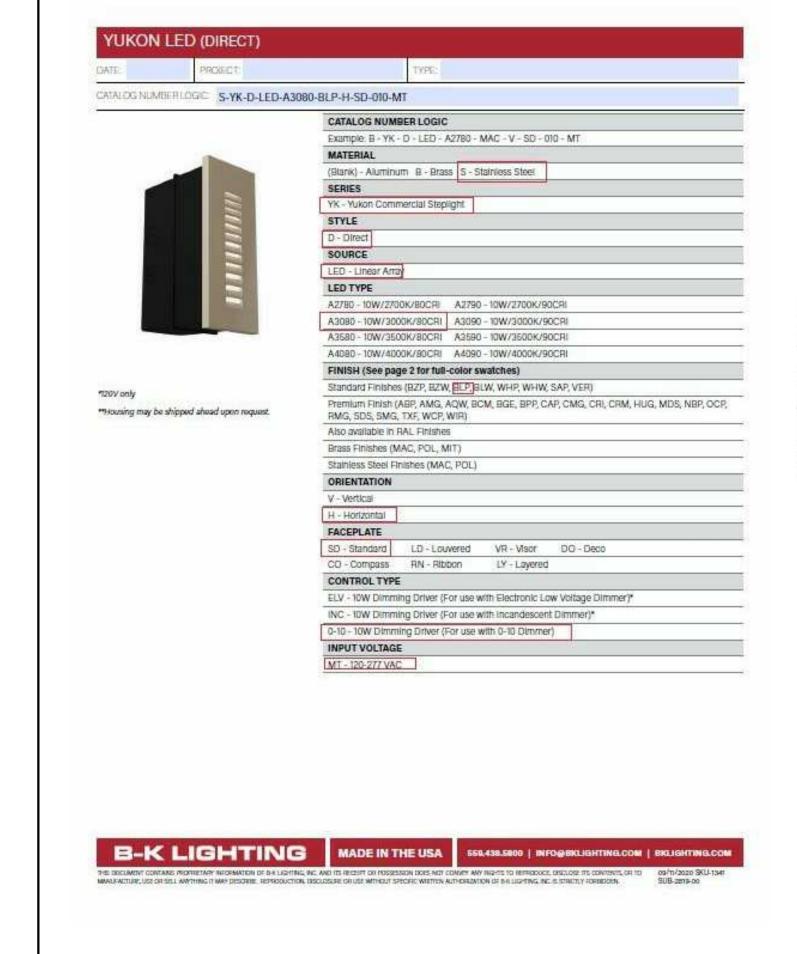



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371 SOUTH MAIN **STREET REDEVELOPMENT**


371 SOUTH MAIN STREET. MEMPHIS, TN 38103

PERMIT SET

REVISIONS

PROJECT NO. DATE 19545 1/22/21 CHECKED DRAWN Checker Author

SITE LIGHTING -CUTSHEETS

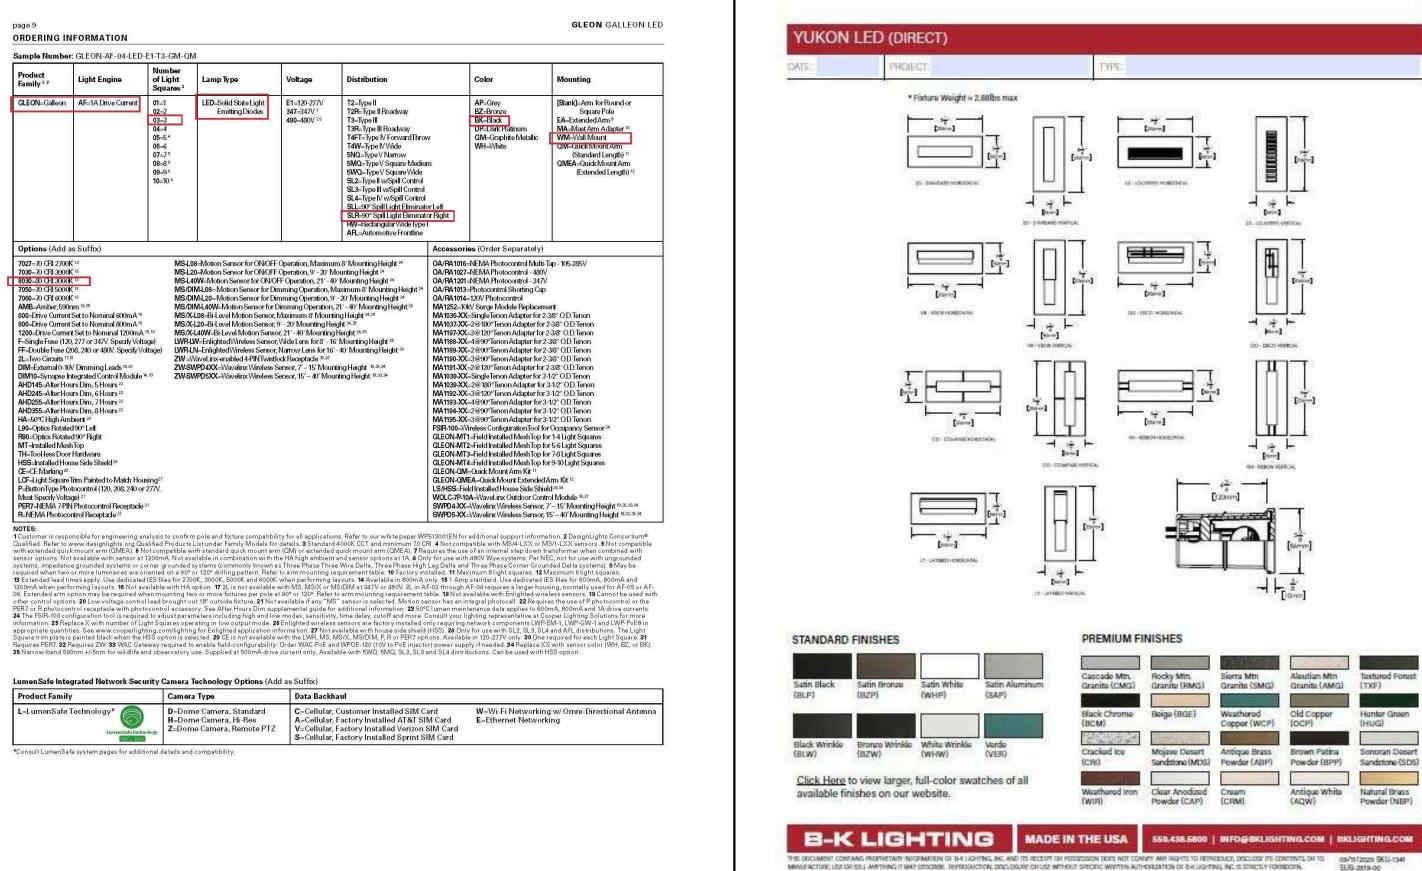

N.T.S.

TYPE SB CUTSHEET

June 2, 2020 12:06 PM

TYPE SA CUTSHEET N.T.S.

BUG Rating

(I) COOPER

 3000K Lumens
 5,727
 11,193
 16,701
 22,06/
 27,341
 32,718
 38,692
 43,841
 48,906
 54,146

 BUG Rating
 B1-U0-G2
 B1-U0-G3
 B2-U0-G4
 B2-U0-G5
 B3-U0-G5
 B3-U0-G5

4000K/5000K Lumens 6,697 13,088 19,528 25,803 31,970 38,258 45,243 51,264 57,185 63,313 3000K Lumens 6,332 12,374 18,463 24,395 30,227 36,171 42,776 48,468 54,066 59,861 BUG Rating B3-U0-G1 B4-U0-G2 B4-U0-G2 B5-U0-G3 B5-U0-G4 B5-U0-G4 B5-U0-G5 B5-U0-G5 B5-U0-G5 4000K/5000K Lumens 6,715 13,122 19,580 25,871 32,055 38,360 45,365 51,401 57,337 63,482

 At 000K/5000K Lumens
 5,604
 10,949
 16,337
 21,586
 26,745
 32,004
 37,850
 42,886
 47,838
 52,965


 BUG Rating
 B1-U0-G2
 B1-U0-G3
 B2-U0-G3
 B2-U0-G4
 B3-U0-G5
 B3-U0-G5<

BUG Rating B3-U0-G1 B3-U0-G2 B4-U0-G2 B5-U0-G3 B5-U0-G3 B5-U0-G3 B5-U0-G4 B5-U0-G5 B3-U0-G5 B

 6,348
 12,406
 18,513
 24,461
 30,307
 36,268
 42,891
 48,599
 54,210
 60,021

 B3-U0-G2
 B4-U0-G2
 B5-U0-G3
 B5-U0-G3
 B5-U0-G4
 B5-U0-G5
 B5-U0-G5
 B5-U0-G5
 B5-U0-G5

6,162 12,040 17,965 23,738 29,413 35,197 41,623 47,163 52,609 58,247

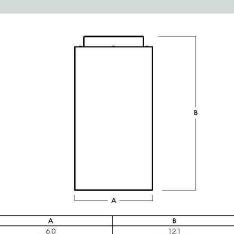

6" SQUARE DIRECT

FOCUSED ILLUMINATION

C0611SQXT - CEILING MOUNT

APPLICATION 6" square x 11" high cylinder luminaire for accent and focused illumination. **FEATURES**

Spectrum's Cylinder series provides traditional architectural style with high performance and energy efficient illumination. Rugged design with flexible mounting, finish and LED options make these extremely versatile fixtures. Quick change LED module with interchangeable optics for job site flexibility and fixture upgrade.

Multi-stage polyester powder-coat process applied on our dedicated paint lines. See mounting and color pages for standard finishes. All exposed materials are chromate pretreated to resist corrosion.

ELECTRONICS

LED system features Xicato LED module with proprietary phosphor technology that provides consistent stable color with CCT control of \pm 100K over life of the light engine. Base CRI is 83 with 2-step MacAdam Ellipse binning. High CRI is 98 with 1 x 2-step MacAdam Ellipse binning. Variety of electronic 120V/277V and dimming drivers. CONSTRUCTION

Fabricated seamless aluminum fixture housing. Specular primary reflector provides high efficiency illumination. Stainless steel hardware with galvanized brackets to resist corrosion. Die-cast aluminum trim. CODE COMPLIANCE

BAA compliant, ETL certified to meet US and Canadian standards, Suitable for dry or damp locations. Wet Location Option. Manufactured and tested to UL standards

PART NUMBER	SOURCE	DELIVERED LUMENS ²	SYSTEM WATTS ³	LPW
O06118@XT10L	1000	910	9.1	100
C06118QXT13L	1300	1227	13.0	94
C06118@XT20L	2000	1887	21.7	87
C06118QXT30L	3000	2831	32.6	87

SERIES	LUMENS1		С	СТ	OPT	ics	DRIVER	R / DIMMING ⁷	OP	TIONS ¹⁰		TRIM		MOUNTING15		INISH ¹⁹
C0611SQXT	10L	1000 Lm	83	CRI	ΧN ⁶	12°	EX	Electronic Driver,	WL11	Wet	TCY ¹²	Same Color	HM16/17	Hang Straight	MW ²⁰	Matte White
	13L	1300 lm	27K	2700K	ND	21°		120V/277V		Location	19	as Cylinder	PM10/17	Rigid Pendant Mount	MB ²⁰	Matte Black
	20L	2000 Lm	30K	3000K	MD	38°	DS10X	10%, 0-10V,	FS	Fuse	TPT	Platinum Silver	AT16/17	Hang Straight All Thread	PT ²⁰	Platinum Silve
	30L4	3000 Lm	35K	3500K	WD	43°		120V/277V		Holder	TCC	Custom Color	CD4X11/17/18	Cord Cable Mount	cc	Custom Colo
			40K	4000K	XW	53°	DOLOX	1%, U+1UV,		and Fuse			SM	Surface Mount		
								120V/277V					COD®	DMX Large Driver Canopy		
			98	CRI ^s			DS2W1	ELV/MLV, 120V				LENS	EMERG	ENCY BATTERY OPTIONS	Se	ee Page 6
			27HK	2700K			DMXS ^{8/9}	DMX Standard			NL ¹¹	No Lens	EMCR	10W Canopy Mounted EM		Full Range of
			30HK	3000K				Configuration			GL13	Clear Glass Lens	EMRM	7W Remote EM		olor Options 83-90095)
			35HK	3500K			DMXC ^{8/9}	DMX				Micro Prism	EMEN	7W Remote with	2	02-90090)
			40HK	4000K				Non-Standard			SO14	Solite™ Lens		Enclosure		
								Custom			FG	Frosted Glass Lens				

EXAMPLE: C0611SQXT13L35KNDEXTPTGLHM12MW

NO.15:

1 Norminal Source Lumens at Any CCT 2 Norminal Delivered Lumens at 83 CRI at Any CCT with MD-TCY-NL-MW 3At 83 CRI 4 Open Aperture Only: NL 5.20 LMax 61.3L Max/XN not Available with 98 CRI Option 7 Contact Factory for Additional Options 8 Contact Factory 9 CGD Required for DMXS/C 10 See Product Options Page for Details 11 Wet Location Unavailable with NL or CD 12 Standard Finish 13 Standard Lens for XN, ND 14 Standard Lens for MWD, XW 15 See Mounting Page for Details on Components and Priches 16 Specially Length in Inches: See Mounting Page for Available Lengths 17 Not for Use in Locations with Wind Exposure 18 EMXXX Option Requires 2 Cords 19 See Color Options/Consult Page for More Options/Consult Page for Mo

SPECTRUM PROJECT:



Dimensions and values shown are nominal. Spectrum Lighting continually works to improve products and reserves the right to make changes which may after the performance or appearance of products


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6" SQUARE DIRECT

FOCUSED ILLUMINATION / FIXTURE OPTIONS





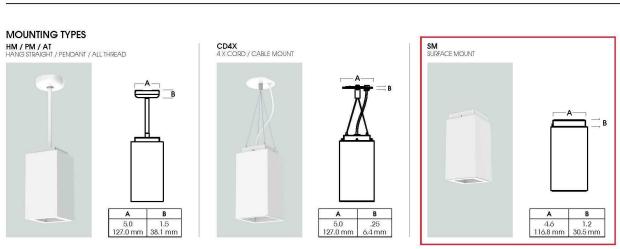


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83-00024_RE

6" SQUARE DIRECT

FOCUSED ILLUMINATION / PHOTOMETRIC DATA

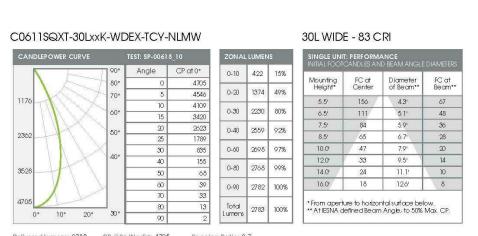

Delivered Lumens: 2783 CP @ 0° (Nadir): 4705 Spacing Ratio: 0.7 Luminaire Walts: 32.6. Beam Angle: 43.1° Output Multipliers: 10L x 0.32, 13L x 0.43, 20L x 0.67

LER: 85 CRI: 83


CANDLEPOWER CURVE	il in	EST: SP-0061	8_18	ZONAL	LUMEN	ıs	SINGLE UNI		ANCE ID BEAM ANGLE	DIAMETERS
	90°	Angle	CP at 0°	0-10	324	11%			1	
	80°	0	3502	V1000000		20020000	Mounting Height*	FC at Center	Diameter of Beam**	FC at Beam**
75	70°	5	3444	0-20	1166	41%			18235-3000	W.C. ALEPTA
0		10	3282	0.00	0110	7.10	5.5'	116	5.5'	46
	60°	15	2998	0-30	2110	74%	6.5'	83		33
	500	20	2581	0-40	2557	90%	7.5'	62	7.4'	25
1-+1//	50"	25	2028	0.40	200,	70.0	8.51	48	7.4' 8.4'	19
		30	1046	0-60	2763	97%	10.0'	35	9,91	14
	40°	40	266				120'	24	11.9	10
26		50	95	0-80	2837	99%	14.0'	18	13.9	7
		60	42	0-90	2853	100%	16.0'	14	15.9'	5
		70	35	0-90	2000	100%				
02		80	15	Total	2854	10000			ntal surface bek	
0° 10° 20°	30°	90	0	Lumens	2004	100%	" AT IESNA d	etined Beam	Angle, to 50%	Max. CP.

 Delivered Lumens:
 2854
 CP ⊕ 0° (Nadir):
 3502
 Spacing Ratio:
 0.86

 Luminaire Watts:
 32.6
 Beam Angle:
 52.8°
 Output Multipliers:
 10L x 0.32, 13L x 0.43, 20L x 0.67

 LER:
 88
 CRI:
 83



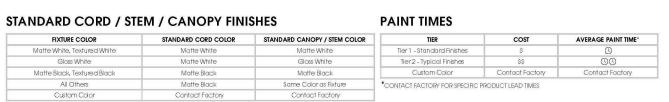

TIER 1 - STANDARD FINISHES

W extured White	TB Textured Black	MT* Textured Silver	OB* Oil Rubbed Bronze	SN Sun Gold	CO CopperMetallic	BR Breochla	GH Graphite	CH Charcoal	AL Almond	VE Verde Green
3L Blue Streak	RD Red Baron	OR Orange	CM Camel	PL Purple	PG Pub Green	TQ Turquoise	SF Sea Foam	PK Pink	AY Aero Yellow	EG Evergreen
L G Jme Green	LB Light Blue	BY Burgundy	AK Anodic Black	AM Anodic Malachite	AZ Anodic Bronze	AS Anodic Sapphire	AN Anodic Natural	AC Anodic Champagn	a	
	agiii bido	- Dailyanay	Thiodo Black	T T T T T T T T T T T T T T T T T T T	A WOOD BIOLES	T I I I I I I I I I I I I I I I I I I I	- Aller and an	The same of the sa		

CUSTOM COLOR FINISHES CONTACT FACTORY

*UNAVAILABLE FOR WET LOCATION


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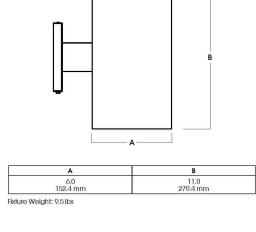
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Type SC







6" SQUARE DIRECT FOCUSED ILLUMINATION

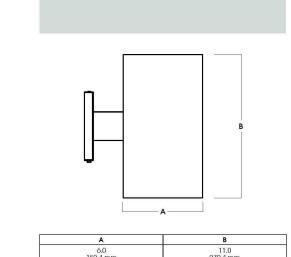C0611SQXT - WALL MOUNT

APPLICATION

6" square x 11" high cylinder luminaire for accent and focused illumination. Spectrum's Cylinder series provides traditional architectural style with high performance and energy efficient illumination. Rugged design with flexible mounting, finish and LED options make these extremely versatile fixtures. Quick change LED module with

Multi-stage polyester powder-coat process applied on our dedicated paint lines. See mounting and color pages for standard finishes. All exposed materials are chromate pretreated to resist corrosion.


interchangeable optics for job site flexibility and fixture upgrade.

ELECTRONICS LED system features Xicato LED module with proprietary phosphor technology that provides consistent stable color with CCT control of +/- 100K over life of the light engine. Base CRI is 83 with 2-step MacAdam Ellipse binning. High CRI is 98 with 1 x 2-step

MacAdam Ellipse binning. Variety of electronic 120V/277V and dimming drivers. CONSTRUCTION Fabricated seamless aluminum fixture housing. Specular primary reflector provides high efficiency illumination. Stainless steel hardware with galvanized brackets to resist corrosion. Die-cast aluminum trim.

CODE COMPLIANCE BAA compliant. ETL certified to meet US and Canadian standards. Suitable for dry or damp locations. Wet Location Option. Manufactured and tested to UL standards No. 1598/8750.

PART	MENS / WAT	DELIVERED	SYSTEM	
NUMBER	LUMENS	LUMENS ²	WATTS ³	LPW
C0611SQXT10L	1000	910	9.1	100
C06118QXT13L	1300	1227	13.0	94
C06118QXT20L	2000	1887	21.7	87
C06118QXT30L	3000	2831	32.6	87

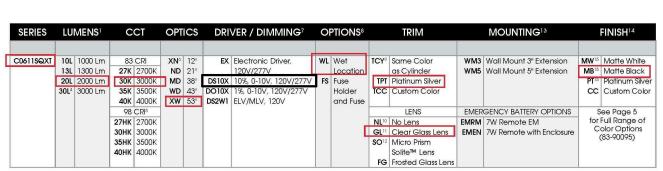

EXAMPLE: C0611SQXT13L35KNDEXTPTGLWM3MW

rice Lumers at Any CCT 2 Nominal Delivered Lumers at 83 CRI at Any CCT with MD-TCY-NI_MW 3 At 83 CRI 4 Open Aperture Only; NIL 5 20L Max 613L Max/XN not Available with 98 CRI Option Page for Abditional Options 8 See Product Options Page for Details 9 Standard Finish 10 Not Available with WL 11 Standard Lens for XNL NID 12 Standard Lens for MID, WID, XW 13 See Mounting Page Components and Rinsites 11 Standard Finishes 15 Standard Finishes 10 Stand





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6" SQUARE DIRECT

STANDARD FINISHES

WALL MOUNT DETAIL

FOCUSED ILLUMINATION / FIXTURE OPTIONS

83-00025_RC

SPECTRUM POWDER COAT COLORS

EMERGENCY BATTERY OPTIONS

*OTHER EM BATTERY SIZES AVAILABLE, CONSULT FACTORY


EMRM* - 7W REMOTE EMERGENCY BATTERY
(50 MAX)
(50 MAX)
(50 MAX)
(50 MAX)

 A
 B
 C

 2.0
 17.0
 6.2

6" SQUARE DIRECT

FOCUSED ILLUMINATION / PHOTOMETRIC DATA

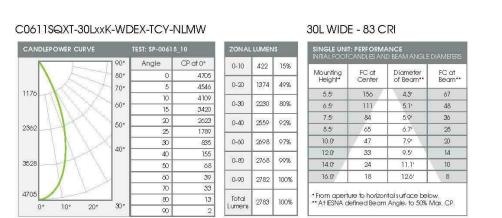


C0611SQXT-30LxxK-XWEX-TCY-NLMW 30L XTRA WIDE - 83 CRI

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Delivered Lumens: 2854 CP @ 0° (Nadir): 3502 Spacing Raflo: 0.86 Luminaire Watts: 32.6 Beam Angle: 52.8° Output Multipliers: 10L x 0.32, 13L x 0.43, 20L x 0.67

COLOR OPTIONS - POWDER COAT PAINT FINISHES

NOTE: NO PRINTED IMAGE CAN EQUAL THE EXACT COLOR OF FINISH ON METAL. SEE INDIVIDUAL SPECIFICATION SHEETS OR CONSULT FACTORY FOR ADDITIONAL INFORMATION.

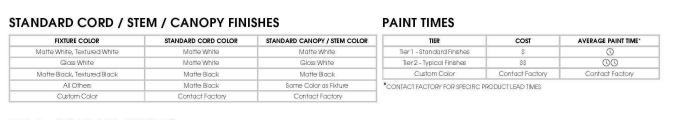

TIER 1 - STANDARD FINISHES
 MW
 GW
 PT
 MB
 BZ

 Matter White
 Gloss White
 Plattnum Silver
 Matter Black
 Bronze



CUSTOM COLOR FINISHES CONTACT FACTORY

*UNAVAILABLE FOR WET LOCATION

83-00025_RC

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A2H, INC. 3009 DAVIES PLANTATION ROAD LAKELAND. TN 38002 P. 901.372.0404 WWW.A2H.COM



GOMEZ FAMILY

371 SOUTH MAIN **STREET REDEVELOPMENT**


371 SOUTH MAIN STREET, MEMPHIS, TN 38103

PERMIT SET

REVISIONS

PROJECT NO. DATE 1/22/21 DRAWN CHECKED Author Checker

SITE LIGHTING -**CUTSHEETS**

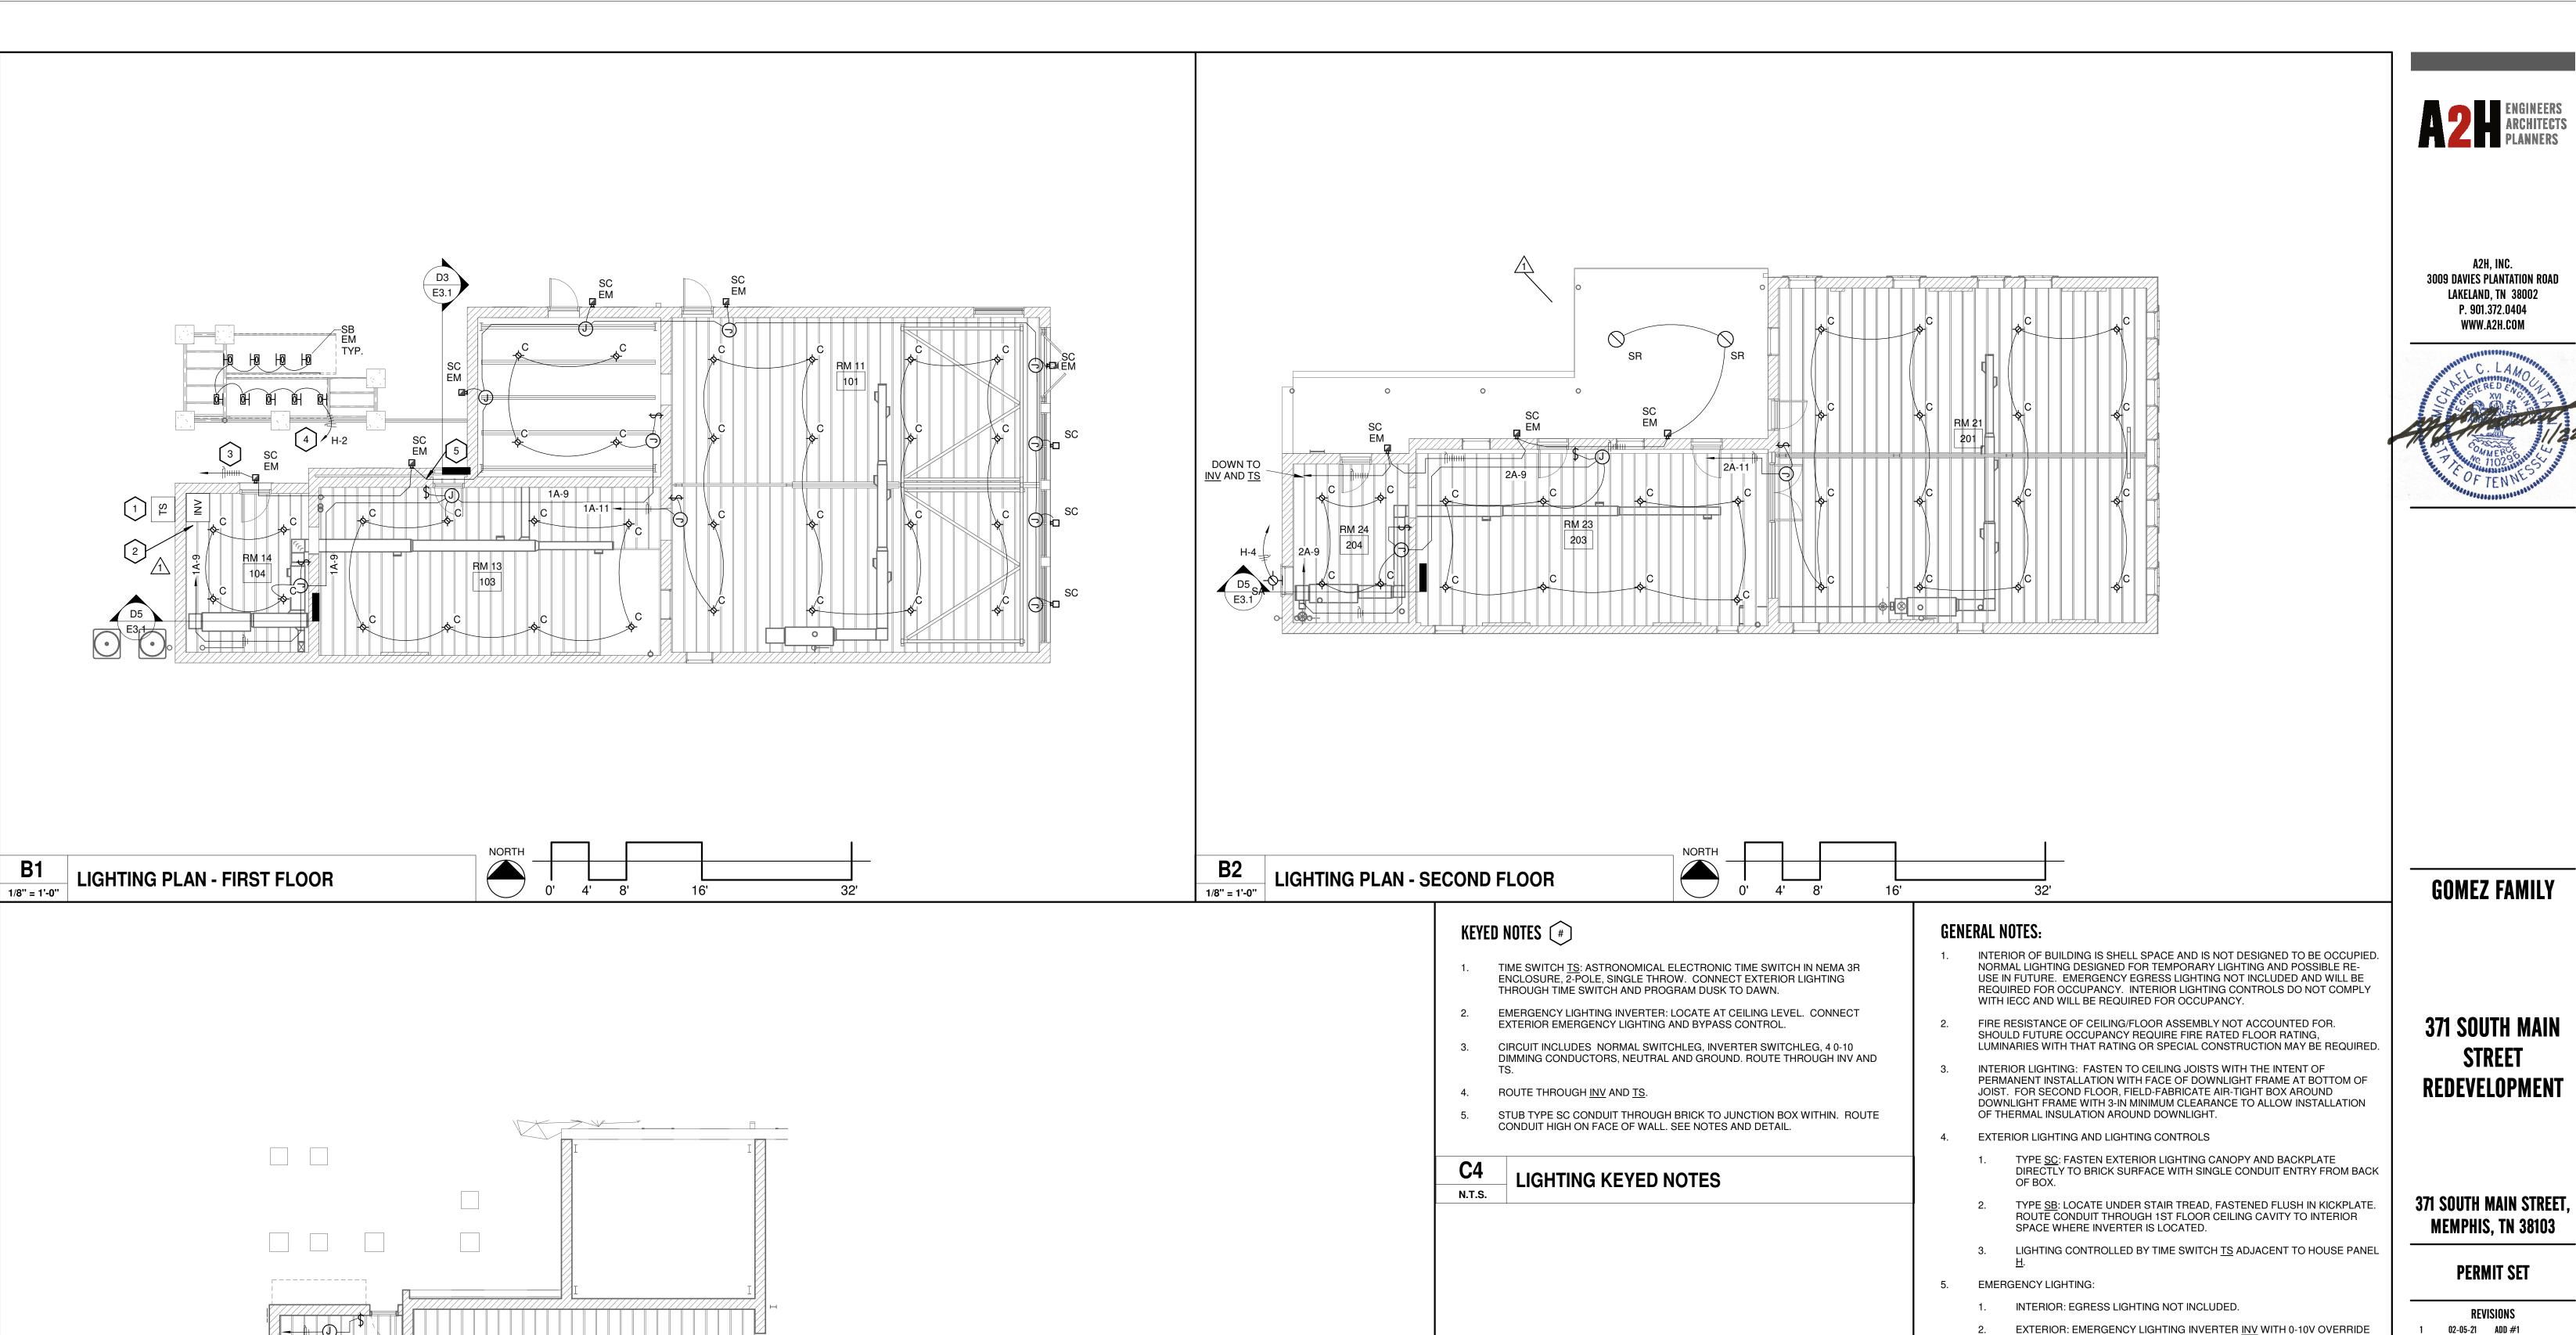

LIGHTING PLAN - CRAWL SPACE

1/8" = 1'-0"

371 SOUTH MAIN STREET

MEMPHIS, TN 38103

PERMIT SET

REVISIONS 02-05-21 ADD #1

PROJECT NO.	DATE
19545	1/22/21
DRAWN	CHECKED

LIGHTING PLANS

N.T.S.

6. CONDUIT AND BOXES: INTERIOR: WALL SWITCHES: SURFACE 4-SQUARE BOX WITH EMT STUBBED TO J-BOX AT CEILING. CONNECT TYPE C WITH MC-CABLE

DIMMING, 250W, SIGNIFY/BODINE ELI-S-250. CONNECT EXTERIOR

- FASTENED TO UNDERSIDE OF CEILING JOISTS. MC-CABLE TO BE REMOVED DURING TENANT INFILL CONSTRUCTION.
- 2. EXTERIOR: ROUTE CONDUITS ALONG CEILING. FUTURE CEILINGS WILL REQUIRE ACCESS TO JUNCTION BOXES.

LIGHTING GENERAL NOTES

YUKON LED (DIRECT)

PROJECT: TYPE DATE:

CATALOG NUMBER LOGIC:



*120V only

**Housing may be shipped ahead upon request.

CATALOG NUMBER LOGIC

Example: B - YK - D - LED - A2780 - MAC - V - SD - 010 - MT

MATERIAL

(Blank) - Aluminum B - Brass S - Stainless Steel

SERIES

YK - Yukon Commercial Steplight

STYLE

D - Direct

SOURCE

LED - Linear Array

LED TYPE

A2780 - 10W/2700K/80CRI A2790 - 10W/2700K/90CRI A3080 - 10W/3000K/80CRI A3090 - 10W/3000K/90CRI A3580 - 10W/3500K/80CRI A3590 - 10W/3500K/90CRI A4080 - 10W/4000K/80CRI A4090 - 10W/4000K/90CRI

FINISH (See page 2 for full-color swatches)

Standard Finishes (BZP, BZW, BLP, BLW, WHP, WHW, SAP, VER)

Premium Finish (ABP, AMG, AQW, BCM, BGE, BPP, CAP, CMG, CRI, CRM, HUG, MDS, NBP, OCP, RMG, SDS, SMG, TXF, WCP, WIR)

Also available in RAL Finishes

Brass Finishes (MAC, POL, MIT)

Stainless Steel Finishes (MAC, POL)

ORIENTATION

V - Vertical

H - Horizontal

FACEPLATE

SD - Standard LD - Louvered VR - Visor DO - Deco

CO - Compass RN - Ribbon LY - Lavered

CONTROL TYPE

ELV - 10W Dimming Driver (For use with Electronic Low Voltage Dimmer)*

INC - 10W Dimming Driver (For use with Incandescent Dimmer)*

0-10 - 10W Dimming Driver (For use with 0-10 Dimmer)


INPUT VOLTAGE

MT - 120-277 VAC




DATE: PROJECT: TYPE:


* Fixture Weight ≈ 2.88lbs max

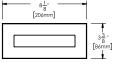


SD - STANDARD HORIZONTAL

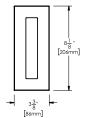


SD - STANDARD VERTICAL

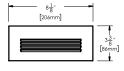


LD - LOUVERED HORIZONTAL

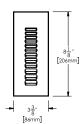


LD - LOUVERED VERTICAL

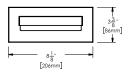


VR - VISOR HORIZONTAL

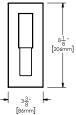


VR - VISOR VERTICAL

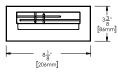


DO - DECO HORIZONTAL

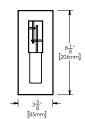


DO - DECO VERTICAL

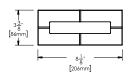


CO - COMPASS HORIZONTAL

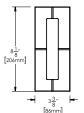


CO - COMPASS VERTICAL

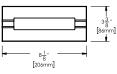


RN - RIBBON HORIZONTAL

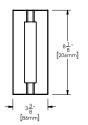


RN - RIBBON VERTICAL

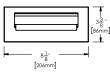

LY - LAYERED HORIZONTAL

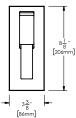

[86mm] LY - LAYERED VERTICAL

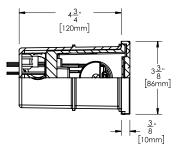

STANDARD FINISHES



Click Here to view larger, full-color swatches of all available finishes on our website.

PREMIUM FINISHES



MADE IN THE USA

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YUKON LED (DIRECT) DATE: PROJECT: TYPE:

Accessories (Configure separately)

SPECIFICATIONS

or con lovino	110	
ELECTRICAL	WATTAGE OPERATING VOLTAGE DRIVER	9.5W 120-277 VAC With [1] 350mA, Class II, constant current integral driver. 50/60 Hz. >0.9 Power Factor, 5A in-rush current(typical at 120 VAC), ≤20%THD (nominal at 120 VAC full load). Output over-voltage, over-current, and short circuit protection with auto recovery. Dimming driver for use with 0-10V, Incandescent, Standard TRIAC, or ELV dimmers. 1-100% range. *TRIAC/ELV dimming at 120 VAC only.
PHYSICAL	MATERIALS HOUSING FACEPLATE WIRING FINISH WARRANTY CERTIFICATION & LISTING	Furnished in copper-free aluminum (6061-T6) Corrosion-free composite, made from high strength, thermo-formed, sheet molded polyester compound. Glass reinforced, flame retardant with knockout plugs and four (4) side flats for 1/2" or 3/4" conduit adapters. Fully machined. Offered with non-visible, tamper-resistant set screws. 18GA Stranded, XLPE, 150°C, 600V wire. StarGuard®, our exclusive RoHs compliant, 15 stage chromate-free process cleans and conversion coats aluminum components prior to application of Class ¼ TGIC polyester powder coating. Brass components are available in powder coat or handcrafted metal finish. Stainless steel components are available in handcrafted metal finish. 5-year limited warranty. UL tested to IESNA LM-79. UL Listed. Certified to CAN/CSA/ANSI Standards. RoHS compliant. Suitable for indoor or outdoor use, in wet locations, and for installation within 4' of the ground. IP66 Rated. Made in the USA.
CUL US LISTED ROHS MADE IN THE		

USA

LAMP & DRIVER DATA (YUKON DIRECT - HORIZONTAL)

DATE: PROJECT: TYPE:

LM79 DATA

OPTICAL DATA

BK No.	CCT (Typ.)	CRI (Typ.)	Input Watts (Typ.)	L70 Data	Orientation	Faceplate	Accessory/ Optic	Roadway Class	BUG	Del. Lumens	Multiplier
A2780	2700	80	9.5	50,000	Horizontal	SD	1	Type II	B0 U3 G1	304.5	0.92
A2790	2700	90	9.5	50,000	Horizontal	SD	1	Type II	B0 U3 G1	252.8	0.83
A3080	3000	80	9.5	50,000	Horizontal	SD	1	Type II	B0 U3 G1	314.5	0.95
A3090	3000	90	9.5	50,000	Horizontal	SD	1	Type II	B0 U3 G1	261.0	0.83
A3580	3500	80	9.5	50,000	Horizontal	SD	1	Type II	B0 U3 G1	334.3	1.01
A3590	3500	90	9.5	50,000	Horizontal	SD	1	Type II	B0 U3 G1	277.5	0.83
A4080	4000	80	9.5	50,000	Horizontal	SD	1	Type II	B0 U3 G1	331.0	
A4090	4000	90	9.5	50,000	Horizontal	SD	1	Type II	B0 U3 G1	274.7	0.83
A2780	2700	80	9.5	50,000	Horizontal	SD	2	Type III	B0 U3 G1	447.1	0.92
A2790	2700	90	9.5	50,000	Horizontal	SD	2	Type III	B0 U3 G1	371.1	0.83
A3080	3000	80	9.5	50,000	Horizontal	SD	2	Type III	B0 U3 G1	461.7	0.95
A3090	3000	90	9.5	50,000	Horizontal	SD	2	Type III	B0 U3 G1	383.2	0.83
A3580	3500	80	9.5	50,000	Horizontal	SD	2	Type III	B0 U3 G1	490.9	1.01
A3590	3500	90	9.5	50,000	Horizontal	SD	2	Type III	B0 U3 G1	407.4	0.83
A4080	4000	80	9.5	50,000	Horizontal	SD	2	Type III	B0 U3 G1	486.0	
A4090	4000	90	9.5	50,000	Horizontal	SD	2	Type III	B0 U3 G1	403.4	0.83
A2780	2700	80	9.5	50,000	Horizontal	LV	1	Type I	B0 U2 G1	122.4	0.92
A2790	2700	90	9.5	50,000	Horizontal	LV	1	Type I	B0 U2 G1	101.6	0.83
A3080	3000	80	9.5	50,000	Horizontal	LV	1	Type I	B0 U2 G1	126.4	0.95
A3090	3000	90	9.5	50,000	Horizontal	LV	1	Type I	B0 U2 G1	104.9	0.83
A3580	3500	80	9.5	50,000	Horizontal	LV	1	Type I	B0 U2 G1	134.3	1.01
A3590	3500	90	9.5	50,000	Horizontal	LV	1	Type I	B0 U2 G1	111.5	0.83
A4080	4000	80	9.5	50,000	Horizontal	LV	1	Type I	B0 U2 G1	133.0	
A4090	4000	90	9.5	50,000	Horizontal	LV	1	Type I	B0 U2 G1	110.4	0.83
A2780	2700	80	9.5	50,000	Horizontal	VR	1	Type I	B0 U2 G1	182.2	0.92
A2790	2700	90	9.5	50,000	Horizontal	VR	1	Type I	B0 U2 G1	151.2	0.83
A3080	3000	80	9.5	50,000	Horizontal	VR	1	Type I	B0 U2 G1	188.1	0.95
A3090	3000	90	9.5	50,000	Horizontal	VR	1	Type I	B0 U2 G1	156.1	0.83
A3580	3500	80	9.5	50,000	Horizontal	VR	1	Type I	B0 U2 G1	200.0	1.01
A3590	3500	90	9.5	50,000	Horizontal	VR	1	Type I	B0 U2 G1	166.0	0.83
A4080	4000	80	9.5	50,000	Horizontal	VR	1	Type I	B0 U2 G1	198.0	
A4090	4000	90	9.5	50,000	Horizontal	VR	1	Type I	B0 U2 G1	164.3	0.83

LAMP & DRIVER DATA (YUKON DIRECT - VERTICAL)

DATE: PROJECT: TYPE:

LM79 DATA

OPTICAL DATA

BK No.	CCT (Typ.)	CRI (Typ.)	Input Watts (Typ.)	L70 Data	Orientation	Faceplate	Accessory/ Optic	Roadway Class	BUG	Del. Lumens	Multiplier
A2780	2700	80	9.5	50,000	Vertical	SD	1	Type II	B0 U3 G1	307.3	0.92
A2790	2700	90	9.5	50,000	Vertical	SD	1	Type II	B0 U3 G1	255.0	0.83
A3080	3000	80	9.5	50,000	Vertical	SD	1	Type II	B0 U3 G1	317.3	0.95
A3090	3000	90	9.5	50,000	Vertical	SD	1	Type II	B0 U3 G1	263.4	0.83
A3580	3500	80	9.5	50,000	Vertical	SD	1	Type II	B0 U3 G1	337.3	1.01
A3590	3500	90	9.5	50,000	Vertical	SD	1	Type II	B0 U3 G1	280.0	0.83
A4080	4000	80	9.5	50,000	Vertical	SD	1	Type II	B0 U3 G1	334.0	
A4090	4000	90	9.5	50,000	Vertical	SD	1	Type II	B0 U3 G1	277.2	0.83
A2780	2700	80	9.5	50,000	Vertical	SD	2	Type II	B0 U3 G1	454.5	0.92
A2790	2700	90	9.5	50,000	Vertical	SD	2	Type II	B0 U3 G1	377.2	0.83
A3080	3000	80	9.5	50,000	Vertical	SD	2	Type II	B0 U3 G1	469.3	0.95
A3090	3000	90	9.5	50,000	Vertical	SD	2	Type II	B0 U3 G1	389.5	0.83
A3580	3500	80	9.5	50,000	Vertical	SD	2	Type II	B0 U3 G1	498.9	1.01
A3590	3500	90	9.5	50,000	Vertical	SD	2	Type II	B0 U3 G1	414.1	0.83
A4080	4000	80	9.5	50,000	Vertical	SD	2	Type II	B0 U3 G1	494.0	
A4090	4000	90	9.5	50,000	Vertical	SD	2	Type II	B0 U3 G1	410.0	0.83
A2780	2700	80	9.5	50,000	Vertical	LD	1	Type I	B0 U2 G1	149.0	0.92
A2790	2700	90	9.5	50,000	Vertical	LD	1	Type I	B0 U2 G1	123.7	0.83
A3080	3000	80	9.5	50,000	Vertical	LD	1	Type I	B0 U2 G1	153.9	0.95
A3090	3000	90	9.5	50,000	Vertical	LD	1	Type I	B0 U2 G1	127.7	0.83
A3580	3500	80	9.5	50,000	Vertical	LD	1	Type I	B0 U2 G1	163.6	1.01
A3590	3500	90	9.5	50,000	Vertical	LD	1	Type I	B0 U2 G1	135.8	0.83
A4080	4000	80	9.5	50,000	Vertical	LD	1	Type I	B0 U2 G1	162.0	
A4090	4000	90	9.5	50,000	Vertical	LD	1	Type I	B0 U2 G1	134.5	0.83
A2780	2700	80	9.5	50,000	Vertical	VR	1	Type I	B0 U2 G1	161.9	0.92
A2790	2700	90	9.5	50,000	Vertical	VR	1	Type I	B0 U2 G1	134.4	0.83
A3080	3000	80	9.5	50,000	Vertical	VR	1	Type I	B0 U2 G1	167.2	0.95
A3090	3000	90	9.5	50,000	Vertical	VR	1	Type I	B0 U2 G1	138.8	0.83
A3580	3500	80	9.5	50,000	Vertical	VR	1	Type I	B0 U2 G1	177.8	1.01
A3590	3500	90	9.5	50,000	Vertical	VR	1	Type I	B0 U2 G1	147.5	0.83
A4080	4000	80	9.5	50,000	Vertical	VR	1	Type I	B0 U2 G1	176.0	
A4090	4000	90	9.5	50,000	Vertical	VR	1	Type I	B0 U2 G1	146.1	0.83